


File Location: Z:\project\2001.01 MOA_PME Replacement of Eklutna Bridge\Civil\ACAD\2001.01-G-Grading & Details.dwg

Plotted: 6/6/2014 10:38 AM

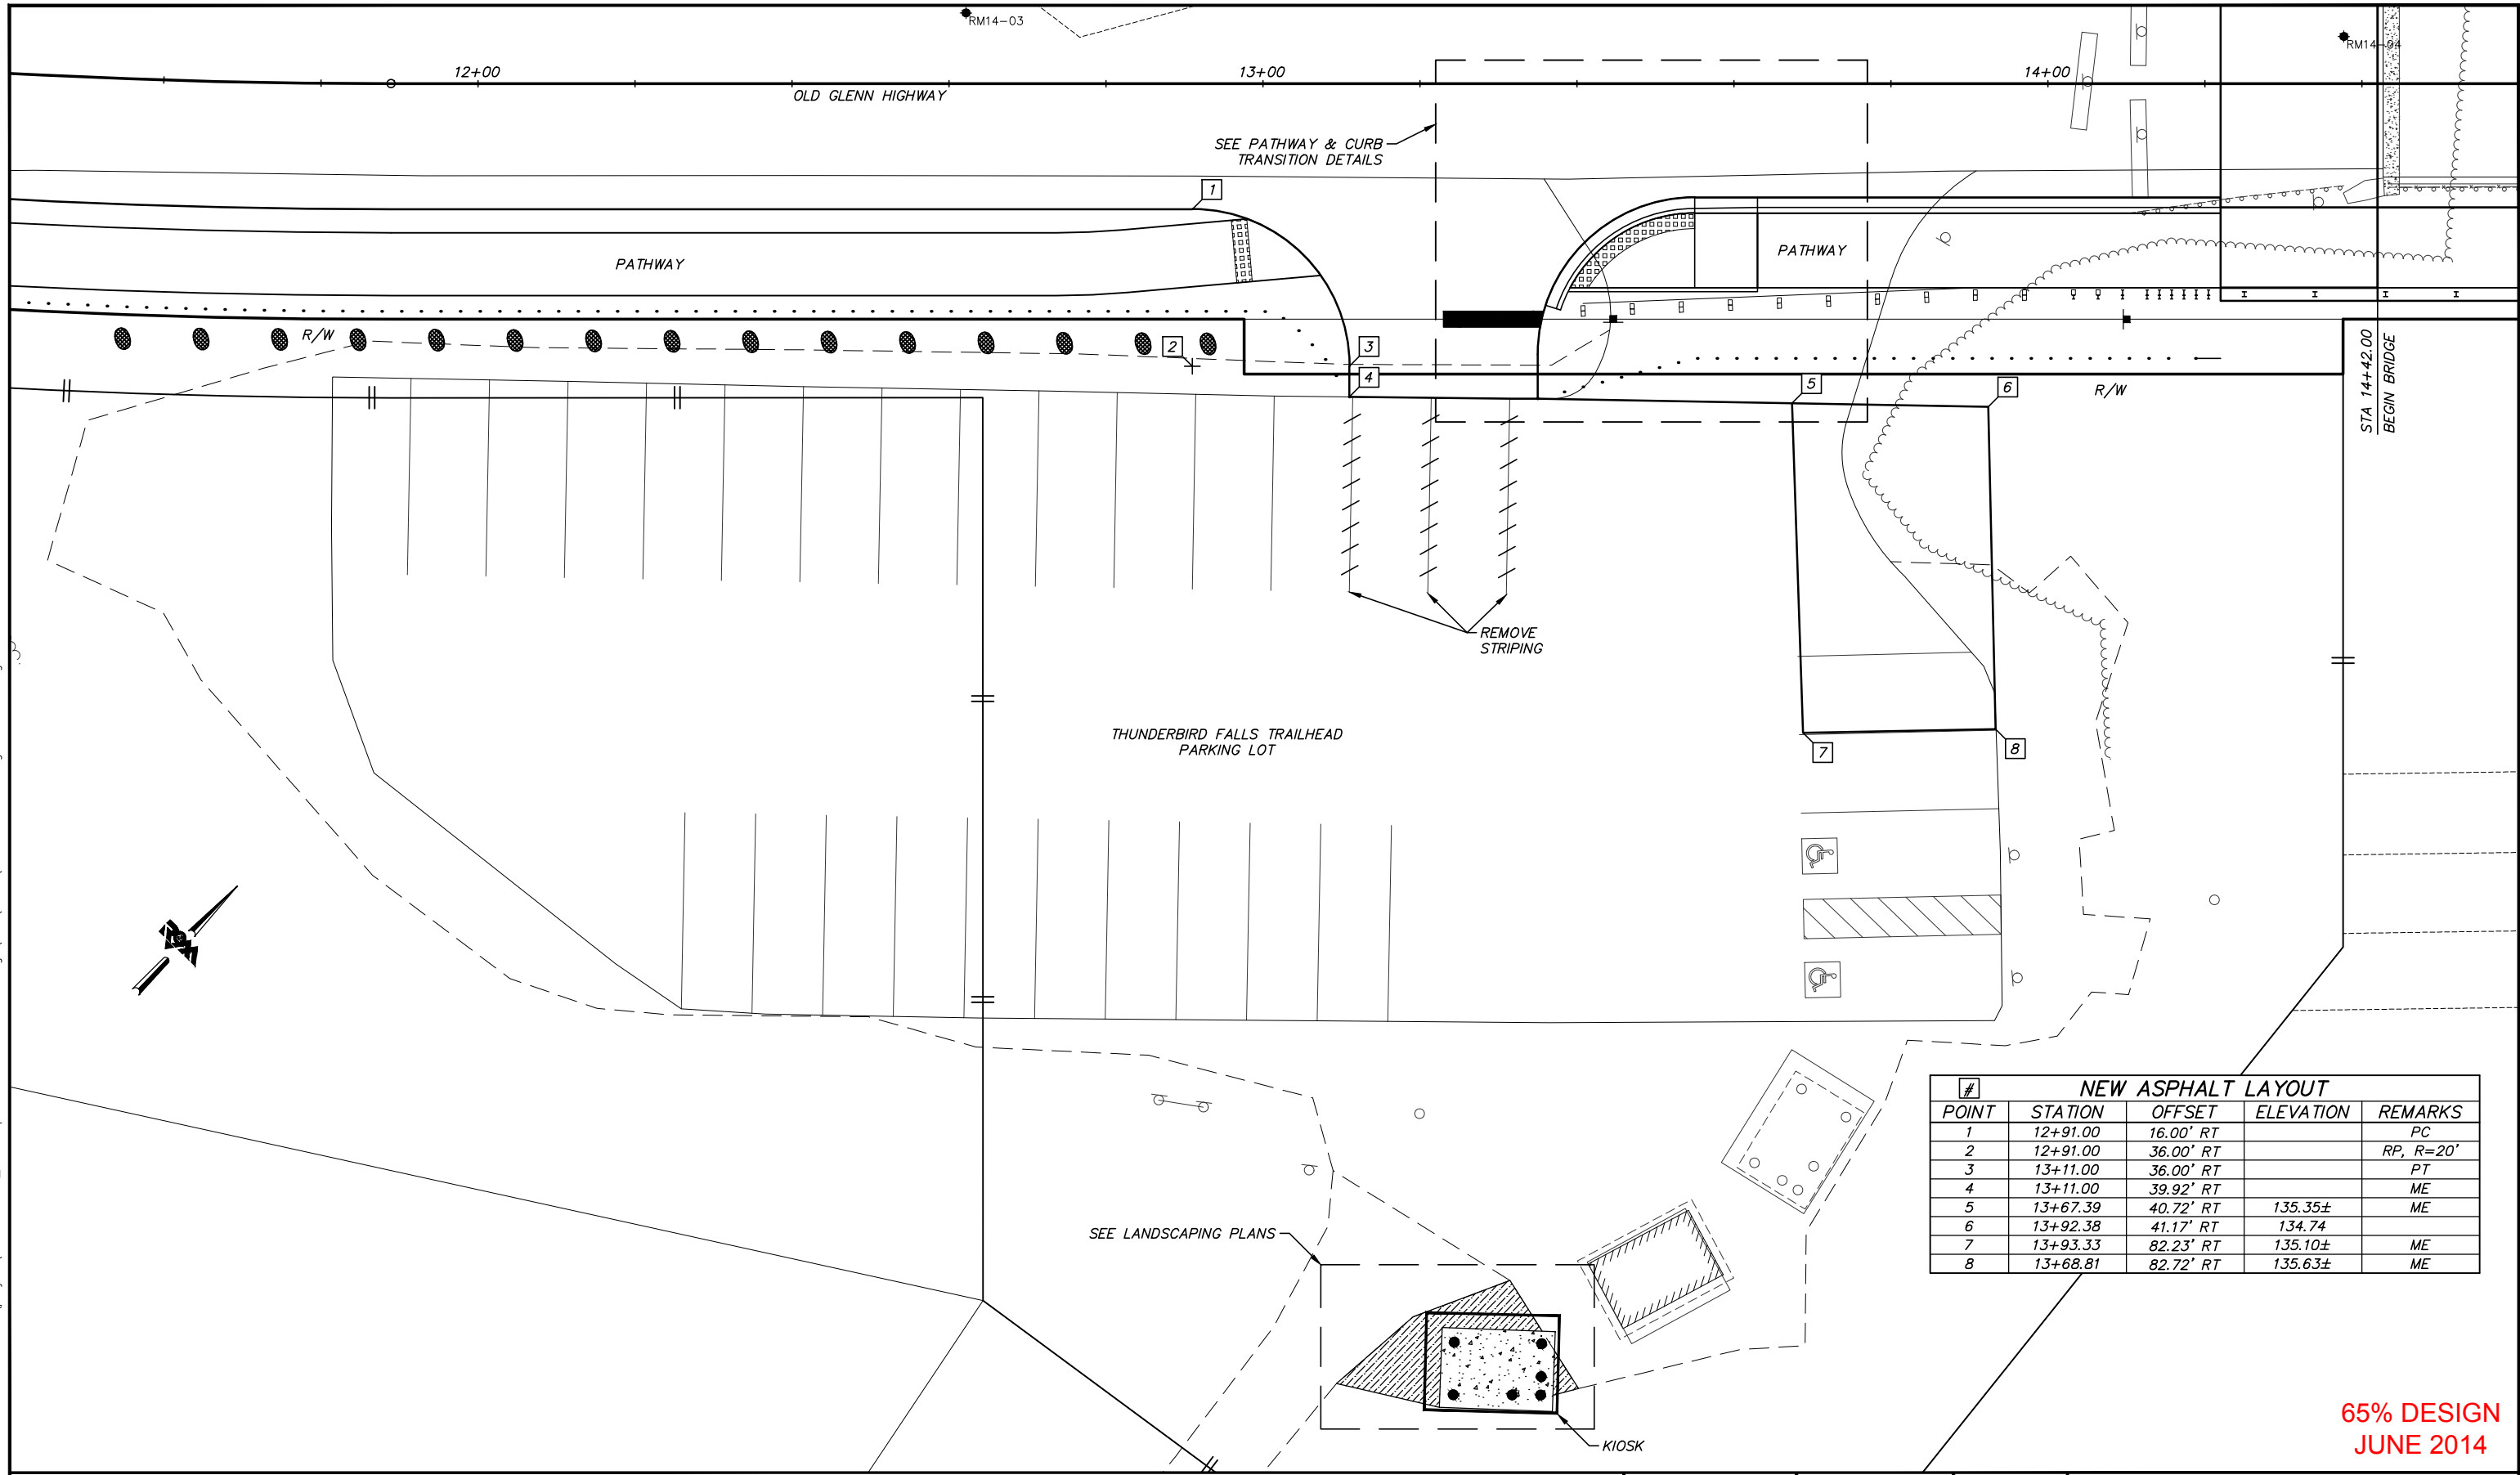

#	NEW ASPHALT LAYOUT			
POINT	STATION	OFFSET	ELEVATION	REMARKS
1	12+91.00	16.00' RT		PC
2	12+91.00	36.00' RT		RP, R=20'
3	13+11.00	36.00' RT		PT
4	13+11.00	39.92' RT		ME
5	13+67.39	40.72' RT	135.35±	ME
6	13+92.38	41.17' RT	134.74	
7	13+93.33	82.23' RT	135.10±	ME
8	13+68.81	82.72' RT	135.63±	ME

**65% DESIGN
JUNE 2014**

FIELD BOOKS	BM NO.	LOCATION	ELEV.	DATA	DRAWN BY	CHECKED BY	DATA	DRAWN BY	CHECKED BY	REV	DATE	DESCRIPTION	BY	REV	DATE	DESCRIPTION	BY
DESIGN				BASE			TELEPHONE										
STAKING				TOPOGRAPHY			ELECTRIC										
ASBUILT				PROFILE			CABLE TV										
CONTRACTOR				SANITARY SEWER			DESIGN										
INSPECTOR				STORM SEWER			QUANTITIES										
				WATER			MUN. FINAL CHK.										
				GAS													
CONSTRUCTION RECORD		VERTICAL DATUM		PLAN CHECK													

R&M
R&M Consultants, Inc.
9101 Vanguard Drive
Anchorage, Alaska 99507
907 522 1707 voice
907 522 3404 fax
www.rmconsult.com



**PROJECT MANAGEMENT AND
ENGINEERING DIVISION**

12-40
EKLUTNA RIVER BRIDGE REPLACEMENT AT OLD GLENN HWY
THUNDERBIRD DRIVE TO EKLUTNA LAKE ROAD
**THUNDERBIRD FALLS TRAILHEAD
PARKING LOT GRADING PLAN**

SCALE 1:10 DATE 6/6/14 GRID NW1965 SHEET 15 of 44
ACCT. NO.